



#### **MEMO**

DATE	July 20, 2021
	Updated July 23, 2021
PROJECT NO.	2103-5995
RE	External Sanitary Sewer Analysis for 1503 Hyde Park Road, City of London
ΤΟ	Paul Di Losa, C.Tech
	Senior Technologist
	Development Services
	City of London
FROM	Daniel Doherty, P.Eng.
	C.F. Crozier & Associates Inc.
CC	Bridgel Patel
	Business Network Associates

This memorandum has been prepared in support of the Zoning By-law Amendment Application [DDI] for the Site located at 1503 Hyde Park Road, in City of London from the perspective of external sanitary sewer capacity. The purpose of this memo is to present the available information about the capacity of the existing municipal sanitary sewer in Coronation Drive including the existing constraints, required updates, and available capacity for the proposed development at 1503 Hyde Park Road, City of London (the Site).

# 1.0 Background

C.F. Crozier & Associates Inc. (Crozier) was retained by Business Network Associates to prepare an external sanitary analysis to analyze the impact of the proposed development on the capacity of the existing external sanitary sewer network. The Site is approximately 0.9 ha and is in a mixed residential and commercial area. It is bounded by a commercial property to the north and south, an existing residential development to the east, and Hyde Park Road to the west. The elements envisioned for this development include one 8-storey apartment building with ground-floor retail and 128 residential units, according to the Site Plan provided by Aci Wright Architects Inc., dated December 2020.

# 2.0 Existing Sanitary Sewer Condition

According to the Sanitary Drainage Area Plan (Plan No. 29547) provided by MTE Consultants, dated June 2020[DD2], the Site is within the sanitary drainage catchment as a part of External Catchment 2, contributing to the existing 250 mm diameter sanitary sewer along Coronation Drive. External Catchment 2 consists of four properties, 1020, 1030, and 1040 Coronation Drive, and 1503 Hyde Park Road (the Site) that convey sanitary flows east towards the existing municipal sanitary sewer on Coronation Drive. A total area of 3.633 ha is assigned to the External Catchment 2 with assigned population of 1,075[NS3] (Sanitary Drainage Area Plan, Plan No. 29547, MTE Consultants, June 2020).

According to Storm and Sanitary Sewer Design Sheet (Plan No. 29549) prepared by MTE Consultants dated June 2020[NS4], there is an existing 200 mm diameter sanitary sewer that conveys the External Catchment 2 to the existing 250 mm diameter sanitary sewer along Coronation Drive.

According to the approved 1040 Coronation Drive Site Servicing Plan (Stantec, September 22, 2014), 1040 Coronation Drive is serviced with internal private 200 mm diameter sanitary sewers, extending from the existing 200 mm diameter as mentioned above. In addition, there is an existing 200 mm diameter sanitary stub located at southeast corner of the Site, in favour of servicing the proposed development at 1503 Hyde Park Road, City of London.

## 3.0 Proposed Sanitary Condition

The proposed development consists of one 8-storey apartment building with ground-floor retail and 128 residential units, according to the Site Plan provided by Aci Wright Architects Inc., dated December 2020.

An equivalent population estimate was determined using population per unit (PPU) densities, in accordance with the 2021 Development Charges Background Study Update (City of London, June 2020). Based on the development concept illustrated in the following drawing, the equivalent population estimates for 1020, 1030, and 1040 Coronation Drive were determined.

- 1020 Coronation Drive: Approved Servicing Plan, prepared by Stantec dated December 18, 2018.
- 1030 Coronation Drive: Approved Site Plan, prepared by Whitney Engineering Inc. dated June 2009.
- 1040 Coronation Drive: Approved Servicing Plan, prepared by Stantec dated September 22, 2014.

Table 1 summarizes the equivalent population estimates for all the properties in External Catchment 2 which is tributary to the existing 250 mm diameter sanitary sewer on Coronation Drive. Detailed calculations are provided in the enclosed document.

Table 1: Equivalent Population Estimates

Proposed Condition for External Catchment 2	Number of Units	Population per Unit	Population Equivalent
1020 Coronation Drive (Existing)	59	1.87	110
1030 Coronation Drive (Existing)	182	1.87	340
1040 Coronation Drive (Existing)	39	3.12	122
1503 Hyde Park Road (Site)	128	1.87	239
Total Popul	812		
Maximum As	1,075		

As shown in Table 1, the total equivalent population estimate including the proposed development and the existing developments in External Catchment 2 is less than the maximum assigned population for External Catchment 2 of 1,075 (Sanitary Drainage Area Plan, Plan No. 29547, MTE Consultants, June 2020). Therefore, the sanitary flows from The Site were accounted for in the design of the existing 250 mm diameter sanitary sewer on Coronation Drive. As the Site has already been accounted for in the external sanitary sewer network, no further capacity analysis is required.

### 4.0 Conclusion

There is an existing 200 mm sanitary stub located in the private laneway east of The Site, in favour of servicing the proposed development. There is an existing 250 mm diameter sanitary sewer along Coronation Drive, which is designed to convey sanitary flows from External Catchment 2 which includes the properties located at 1020, 1030, and 1040 Coronation Drive and the Site. External Catchment 2 accounts for a development area of 3.633 ha and a population of 1075 persons.

The proposed development on The Site consists of one 8-storey apartment with 128 units, having an equivalent population of 239 persons. With consideration for proposed development, External Catchment 2 has a total population of 812, which is less than the maximum assigned population of 1,075. Therefore, the proposed development was accounted for in the design of existing 250 mm diameter sanitary sewer on Coronation Drive (Sanitary Drainage Area Plan, Plan No. 29547, MTE Consultants, June 2020) and no further analysis is required.

Sincerely,

C.F. CROZIER & ASSOCIATES INC.

众為

Shiying (Heaven) Lin, E.I.T. Land Development

HL/kb

Encl. 1. Population Comparison

- 2. 1020 Coronation Drive Servicing Plan
- 3. 1030 Coronation Drive Site Plan
- 4. 1040 Coronation Drive Servicing Plan
- 5. Sanitary Drainage Area Plan

C.F. CROZIER & ASSOCIATES INC.

Daniel Doherty, P.Eng. Land Development

I:\2100\2103- Business Network Associates\5995- 1503 Hyde Park\Memos\2021.07.20\_Sewer Analysis Memo.docx



**Project:** 1503 Hyde Park Rd

Project No.: 2103-5993 Created: 2021-06-15

Created By: HL
Checked By: DD/NRS
Revised: 2021-06-25

# **External Sanitary Analysis - Population Comparison**

#### **External Catchment 2**


Assigned Area: 3.633 ha
Assigned Population: 1075 Persons


Proposed Condition for External	Number of Units	Population per	Population
Catchment 2		Unit	Equivalent
1020 Coronation Drive (Existing)	59	1.87	110
1030 Coronation Drive (Existing)	182	1.87	340
1040 Coronation Drive (Existing)	39	3.12	122
1503 Hyde Park Road (Site)	128	1.87	239
Total Popula	812		


Note: 1. Assigned area and population for External Catchment 2 per Drawing No. 29547 provided by City of London, dated June 2020.

- 2. Number of units for 1020 Coronation Drive per approved Servicing Plan, prepared by Stantec dated December 18, 2018. (Assume units are 2-bedroom apartments.)
- 3. Number of units for 1030 Coronation Drive per approved Site Plan, prepared by Whitney Engineering Inc. dated June 2009. (Assume units are 2-bedroom apartments.)
- 4. Number of units for 1040 Coronation Drive per approved Servicing Plan, prepared by Stantec dated September 22, 2014. (Assume units are single family dwelling.)
- 5. Population per units are based on 2021 Development Charges Background Study Update, provided by City of London, dated June 2020.

Single Family Dwelling: 3.12 Multiple Unit Dwelling: 2.11 Apartment 1-Bedroom: 1.38 Apartment 2-Bedroom: 1.87

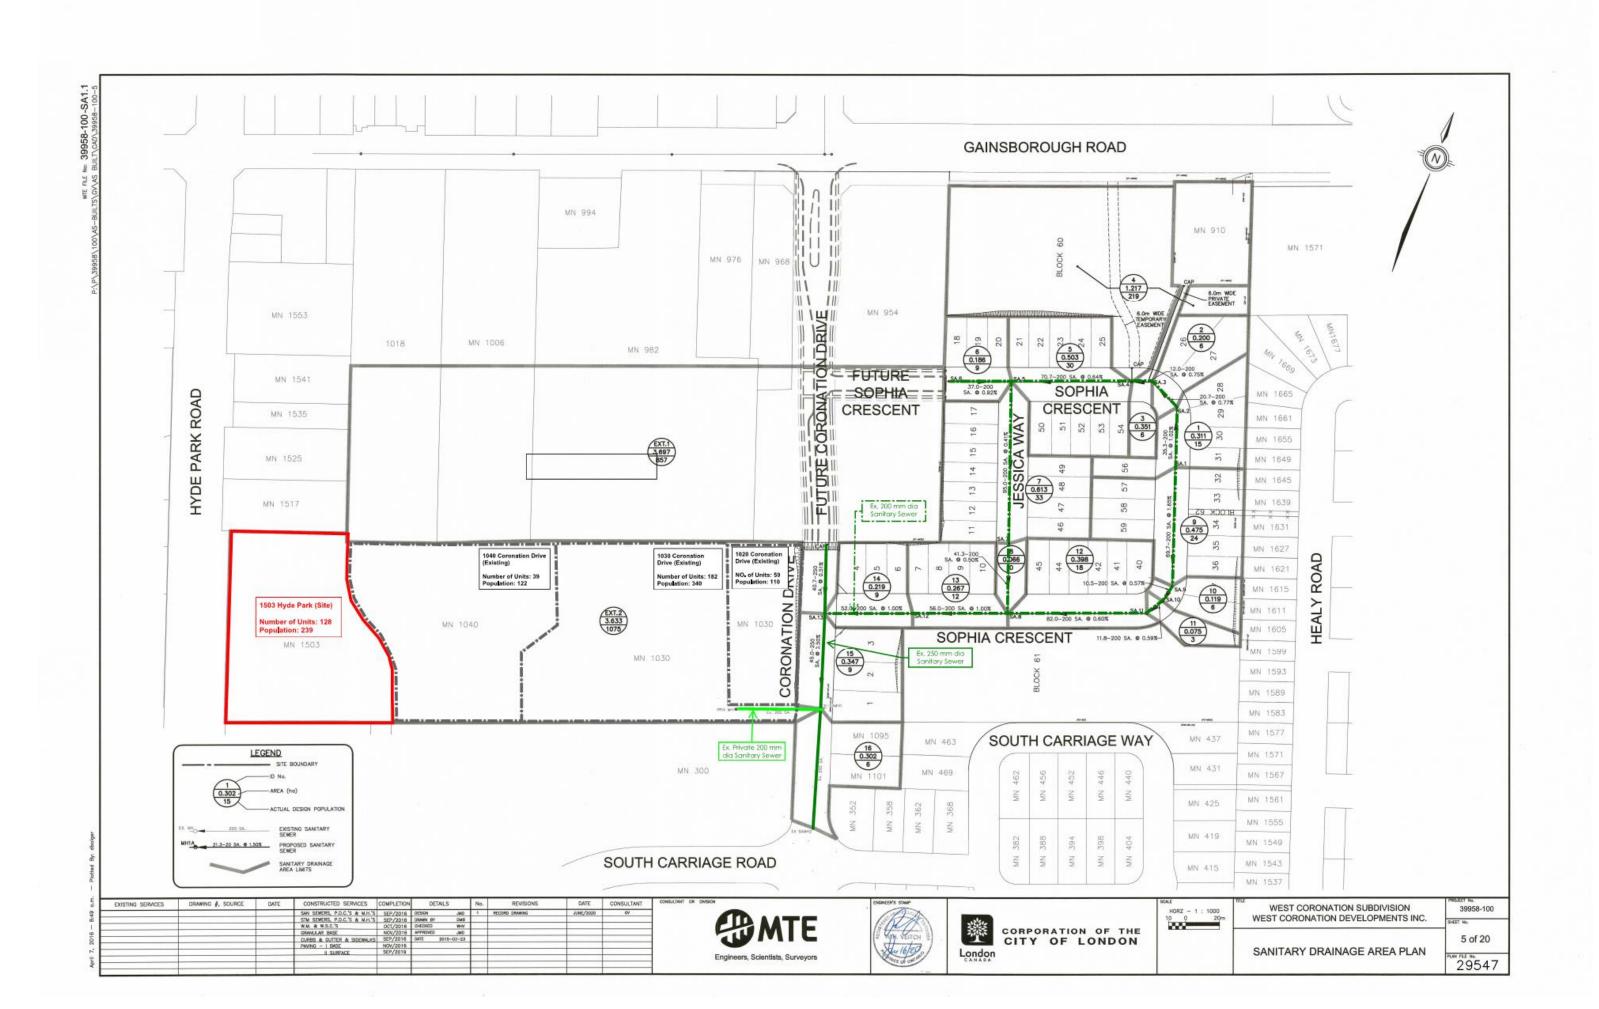


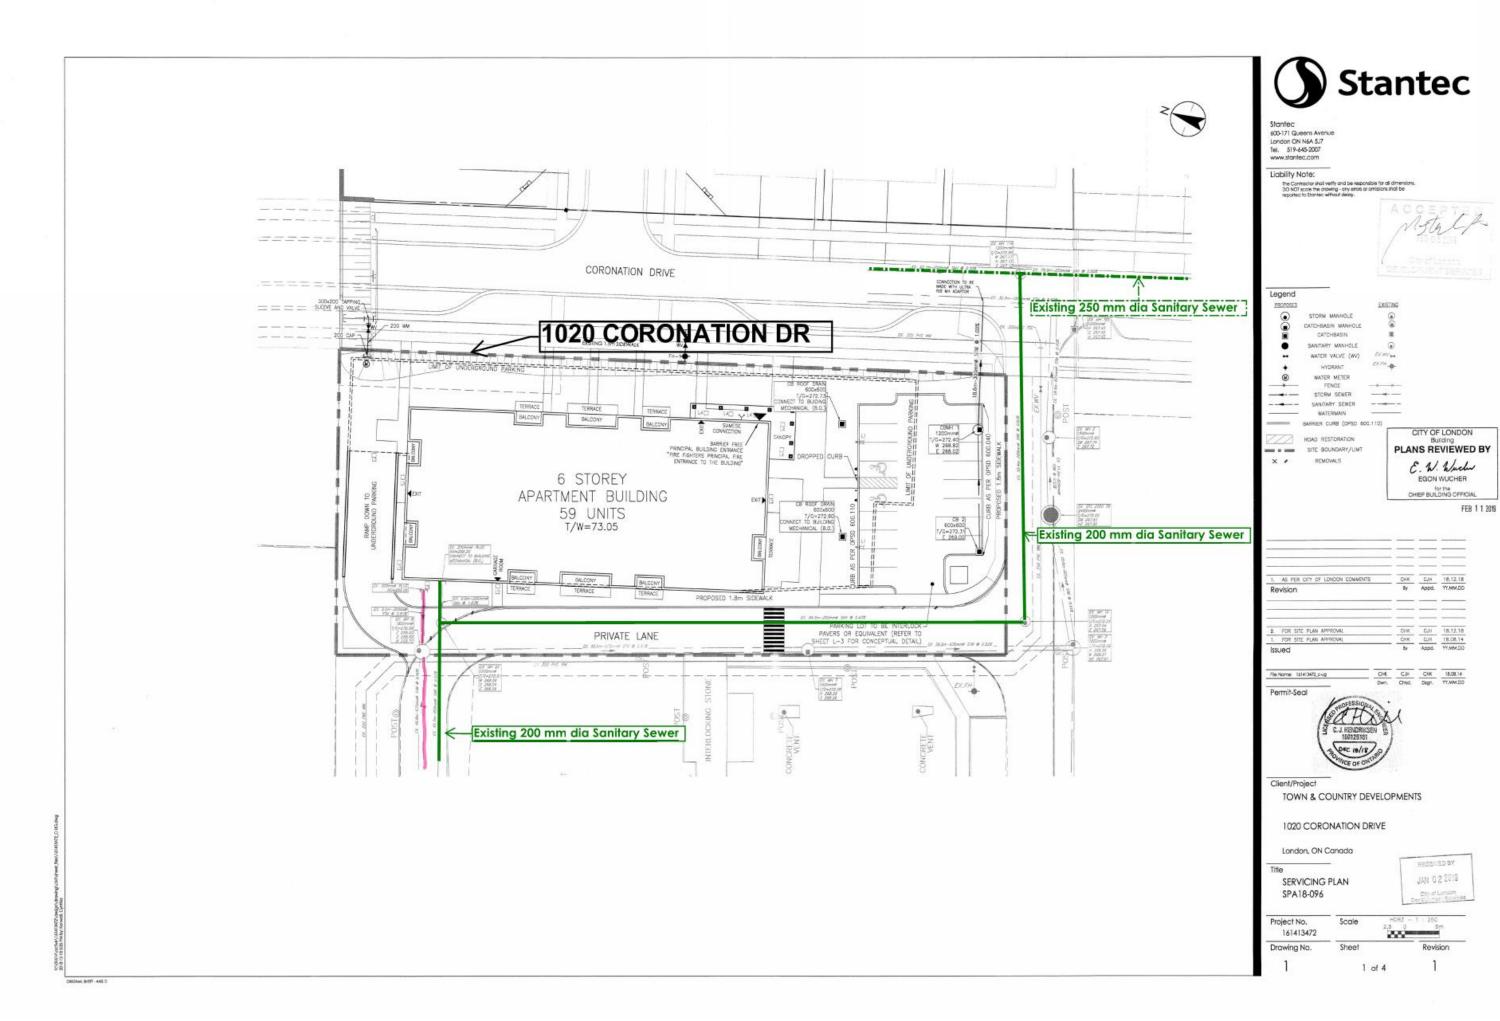

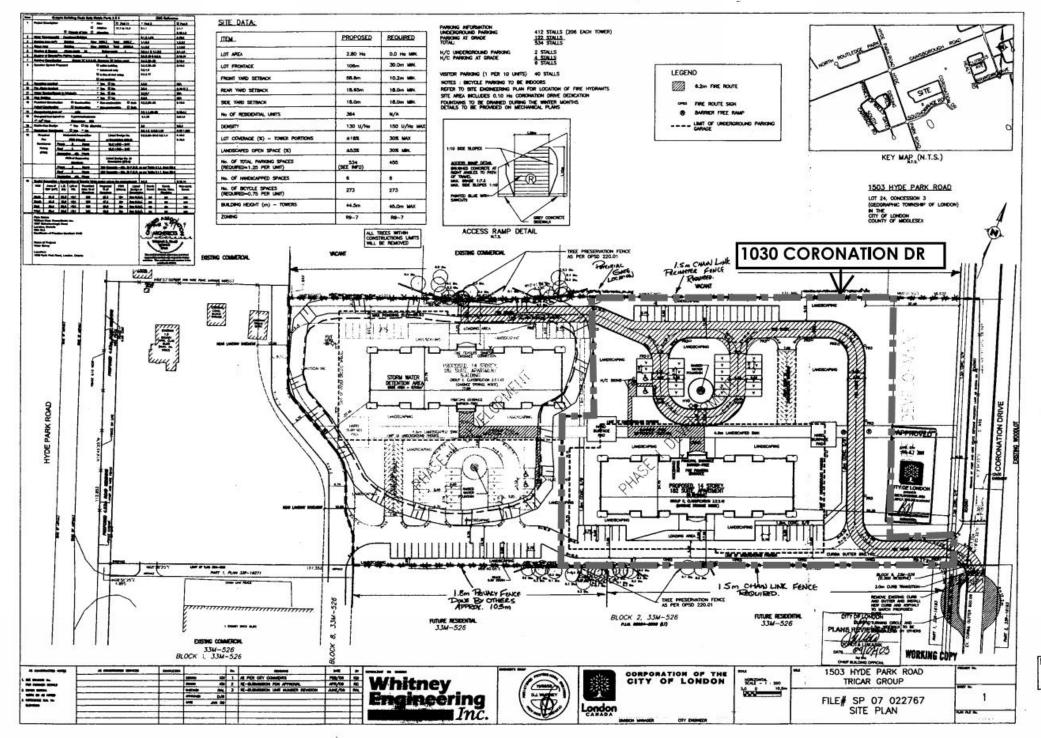

Drawing Author: Whitney Engineering Inc.
Drawing Number: 1
Date of Drawing: February, 2009
Drawing Latest Revision Date: June, 2009
Items Amended by Hand: Perimeter fence 1.5m chain link
Date Amended by Hand: July 15, 2009
Municipal Address: 1503 Hyde Park Road
Drawing Sealed by: D.J. Whitney, P.Eng.
City File Number: SP 07-022767

RECEIVED
JUN 2 3 2009
BRIDING BRISHN

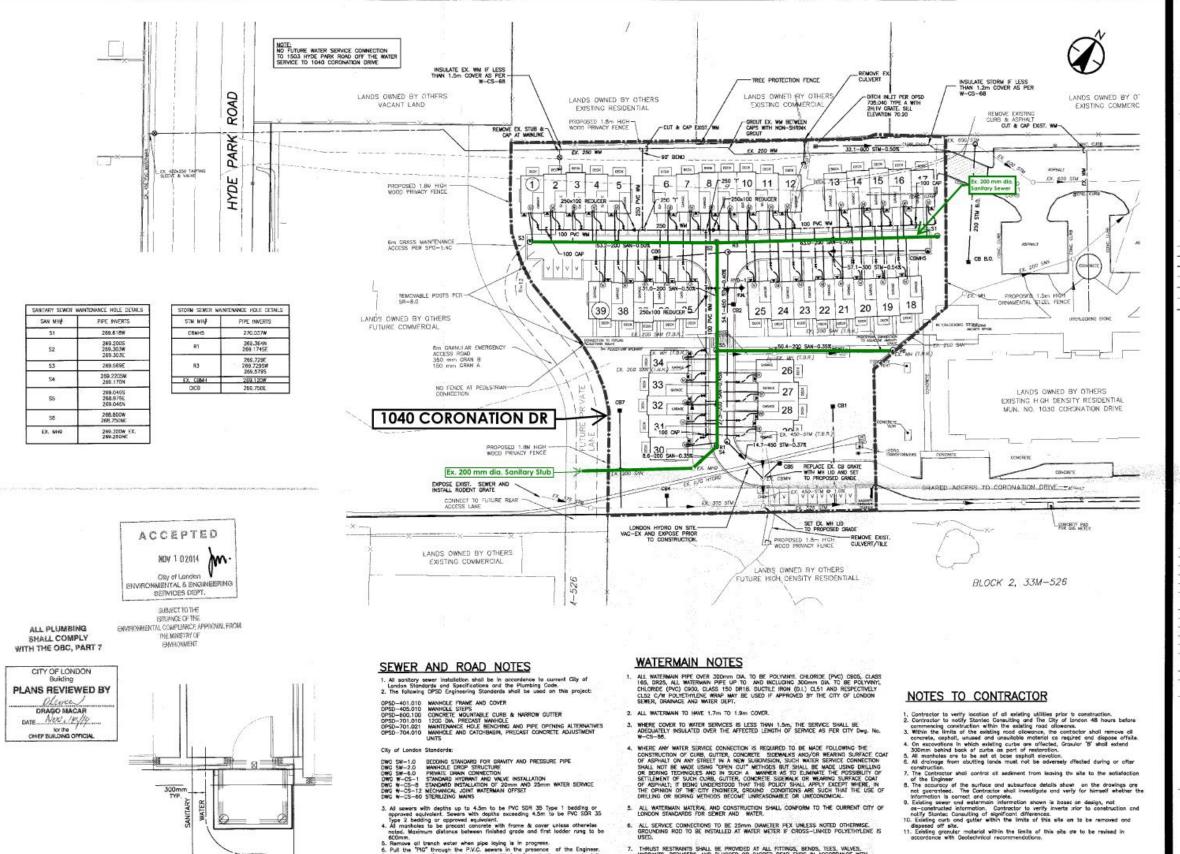

500-171 Queens Avenue London, ON. el. 519-645-2007

#### Convright Reserved

The Contractor shall verify and be responsible for all dimensions. DO NOT scale the downly- any errors or orbistnes shall be reported to Stantiac Without delay.

The Copyright to the delays and attacking any the property of Stantiac Without delay are to reproduce the property of Stantiac, Reproduction or use for any purpose other than that

Consultants

Legend

EX. WATERMAIN PROPOSED WATERMAIN WATERWAIN OFFSET EX. STORM SEWER PROPOSED STORM SEWER EX. SANITARY SEWER PROPOSED SANITARY SEWER PROPOSED STORM MANHOLE PROPOSED STORM CATCH BASIN MANHOLE PROPOSED SANITARY MANHOLE EX. SANITARY MANHOLE PROPOSED CATCH BASIN

EX. CATCH BASIN EX. GAS VALVE EX. WATER VALVE

(4)

PROPOSED WATER METER

EX. TREE DEVELOPMENT BOUNDARY

0

(LH.R.) EXISTING INFRASTRUCTURE TO BE REMOVED

Revision PER COL COMP CH CH Appd. 14.02.06 Issued YY.MM.DD CH AH 13.12.02 Cred Dign. YY.MM.DO

Permit-Seal



TOWN & COUNTRY DEVELOPMENT

1040 CORONATION DRIVE SP14-014332 LONDON

SERVICING PLAN

RECEIVED BY SEP 2 S 2014

CITY OF LONDON DEVELOPMENT SERVICES

Project No. Scale 1:500 161403394 Sheet Revision 2 1<sub>of</sub> 2

All catchbasin leads to be 250mm diameter at a minimum arade of 1% unless otherwise noted.

7. THRUST RESTRAINTS SHALL BE PROVIDED AT ALL FITTINGS, BENDS, TEES, VALVES, HYDRANTS, REQUERIS, AND PLUGGED OR CAPPED DEAD ENDS IN ACCORDANCE WITH SECTION 441-07.25 - THRUST RESTRAINTS, OF THE CITY OF LONDON SUPPLEMENTAL STANDARDS FOR SEMER AND WAITER (LAIEST REMSION. CURRENT EDITION AT THE TIME OF THIS PRINTING IS DATED NOWEMER 14, 2011). FOR WAITERMAIN LAGGET THAN SOUTH OF INSTALLATION STUMMONS NOT INCLUDED IN SECTION 441.07.23. THE CONTRACTOR SHALL SUBMIT SHOP DEARWINS WITH RESTRAINT AS RECOMMENDED BY THE PIPE MANUFACTUREN FOR THE REVIEW AND APPROVAL OF THE CITY OF LONDON.

8. ALL FIRE HYDRANTS SHALL BE 3-WAY HYDRANTS WITH STORZ CONNECTION OPENING CLOCKWISE.

ALL WATERWAIN VALVES SHALL BE GATE VALVES MANUFACTURED TO AWAYA C-550. ALL VALVES TO OPEN CLOCKWISE.

11. FOR WATERMAN CROSSING OVER SEWERS AND PDC's, 0.15m MINIMUM CLEARANCE IS REQUIRED TO ALLOW FOR PROPER BEDONIC AND SUPPORT, FOR MATERMAN CROSSING UNDER SEWERS AND PDC's, 0.5m MINIMUM CLEARANCE IS REQUIRED BETWEEN THE INVERT OF THE SEWER OR PDC AND THE CROWN OF THE WATERMARM.

TYPICAL UNIT SERVICING